

WURZBACH PUMP STATION IMPROVEMENTS PROJECT

Solicitation Number: CO-00239 Job No.: 15-6003

ADDENDUM 4 November 6, 2018

To Bidder of Record:

This addendum, applicable to work referenced above, is an amendment to the bid proposal, plans and specifications and as such will be a part of and included in the Contract Documents. Acknowledge receipt of this addendum by entering the Addendum number and issue date on the space provided in submitted copies of the bid proposal.

CHANGES TO THE PLANS

- **1. Sheet S12:** Replace in entirety with the attached.
- 2. Sheet E9:
 - a. Revise the "SPD" item shown on each bus to "SA" item (Surge Arrestor). The Surge arrestors shall be per 16340-2.04.B.
 - b. The CPTs shall be connected to the bus and not the capacitor trip device (CD).
 - c. The 120/240V Power Panel shall be connected to the capacitor trip devices and not the 86 devices.
 - d. The top Bus A Breaker shall be re-labeled as "52 A1". The bottom Bus A breaker shall be re-labeled as "52 A2".
 - e. The top Bus B Breaker shall be re-labeled as "52 B1". The bottom Bus B breaker shall be re-labeled as "52 B2".
- **3. Sheet E30:** Replace in entirety with the attached.
- **4. Sheet E33:** Replace in entirety with the attached.



Grubb Engineering, Inc.
TBPE Firm Registration No. 3904

END OF ADDENDUM

TEMPORARY SPECIAL SHORING GENERAL NOTES

- 1. TEMPORARY SPECIAL SHORING WILL BE REQUIRED DURING CONSTRUCTION OF THE PROPOSED FOUNDATION CONCRETE SLABS AND WALLS FOR THE PURPOSES OF:
 - A. TO PROVIDE A SAFE AND SECURE WORK SITE DURING THE EXCAVATION REQUIRED FOR THE ELECTRICAL BUILDING OF THIS STRUCTURE ON THIS PROJECT.
 - B. TO HOLD AND PREVENT SURROUNDING EARTH, WATER OR BOTH FROM ENTERING THE WORK AREA AS A RESULT OF THE PROPOSED EXCAVATION.
 - C. PROTECT EXISTING INFRASTRUCTURE ELEMENTS DURING THE CONSTRUCTION OF THE NEW FACILITIES.
- THE CONTRACTOR WILL BE RESPONSIBLE FOR THE SPECIAL SHORING LAYOUT AND DESIGN. PRIOR TO DESIGN OF THE SPECIAL SHORING THE CONTRACTOR WILL BE RESPONSIBLE FOR IDENTIFYING LOCATING AND SURVEYING ALL EXISTING FEATURES, BOTH BURIED AND OVERHEAD, WHICH WILL BE REQUIRED TO BE RESTRAINED, PROTECTED OR COULD BE IN CONFLICT WITH CONSTRUCTION OF THE PROPOSED STRUCTURE AND THE SPECIAL SHORING. THE CONTRACTOR SHALL SUBMIT DETAILS AND DESIGN PLANS AND CALCULATIONS PREPARED BY AND BEARING THE SEAL OF A LICENSED PROFESSIONAL ENGINEER IN THE STATE OF TEXAS, FOR REVIEW AND COMMENT BY THE OWNER, PRIOR TO BEGINNING ANY SPECIAL SHORING CONSTRUCTION. THE OWNER RESERVES THE RIGHT TO REJECT ANY DESIGNS SUBMITTED. REVIEW AND ACCEPTANCE OF THE DESIGN BY THE OWNER DOES NOT RELIEVE THE CONTRACTOR FROM RESPONSIBILITY FOR THE COMPLETION OF THE WORK OR FROM LIABILITY FOR REPAIR OR REPLACEMENT OF DAMAGED PORTIONS OF ANY EXISTING OR NEW STRUCTURES DUE TO THE METHODS ACCEPTED AND EMPLOYED.

DESIGN OF THE SPECIAL SHORING SHALL CLEARLY IDENTIFY THE METHODS, MATERIALS, OTHER SUPPORTS AND OTHER EQUIPMENT PROPOSED FOR USE, AS WELL AS THE PROPOSED CONSTRUCTION SEQUENCE.

DESIGN OF THE TEMPORARY SPECIAL SHORING SHALL COMPLY WITH OSHA STANDARDS AND INTERPRETATIONS, 29 CFR 1926, SUBPART P, EXCAVATIONS. DESIGN OF TEMPORARY SPECIAL SHORING STRUCTURAL SYSTEMS SHALL COMPLY WITH AISC CODE OF STANDARD PRACTICE, ACI 347-04 GUIDE TO FORMWORK FOR CONCRETE, SHEET PILING DESIGN MANUAL AND AASHTO STANDARD SPECIFICATION FOR HIGHWAY BRIDGES.

- 3. THE DESIGN OF SPECIAL SHORING SHALL ACCOUNT FOR THE CURRENTLY EXISTING SOIL PROPERTIES AND THE SOIL PROPERTIES FOR ANY REQUIRED SELECT BACKFILL UNDER OR AGAINST THE PROPOSED STRUCTURE. THE DESIGN OF SPECIAL SHORING SHALL ALSO ACCOUNT FOR ANY TEMPORARY TRAFFIC OR EQUIPMENT SURCHARGE LOADS, WHICH MAY BE NECESSARY FOR NORMAL PLANT OPERATIONS AND FOR CONSTRUCTION OF THE PROPOSED STRUCTURE. THE OWNER HAS LIMITED EXISTING SOIL INVESTIGATION INFORMATION, IN THIS AREA, AVAILABLE FOR REVIEW BY THE CONTRACTOR HOWEVER THE CONTRACTOR SHALL NOT RELY UPON THIS INFORMATION FOR THE DESIGN OF THE SPECIAL SHORING. THE CONTRACTOR WILL BE RESPONSIBLE FOR OBTAINING THE SERVICES OF A PROFESSIONAL ENGINEER FOR DETERMINATION OF IN—SITU SOIL DESIGN PROPERTIES FOR USE IN DESIGN OF THE SPECIAL SHORING.
- 4. CONTRACTOR SHALL BE RESPONSIBLE FOR SUBMITTING TO OWNER FOR APPROVAL, ALL BACKFILL MATERIAL PROPOSED TO BE UTILIZED BETWEEN THE SPECIAL SHORING AND PERMANENT STRUCTURES. SUCH BACKFILL SHALL BE CONSISTENT WITH REQUIREMENTS OF BACKFILL SPECIFIED, ELSEWHERE IN THESE PLANS, FOR USE AT OTHER PERMANENT STRUCTURES ON THIS PROJECT.
- 5. CONTRACTOR SHALL BE REQUIRED TO PROVIDE OWNER WITH ACCURATE "AS BUILT DRAWINGS" FOR ANY SPECIAL SHORING WHICH SHALL REMAIN IN PLACE, AFTER PERMANENT CONSTRUCTION IS COMPLETED.



15-6003

JOB NO.

16-12-18

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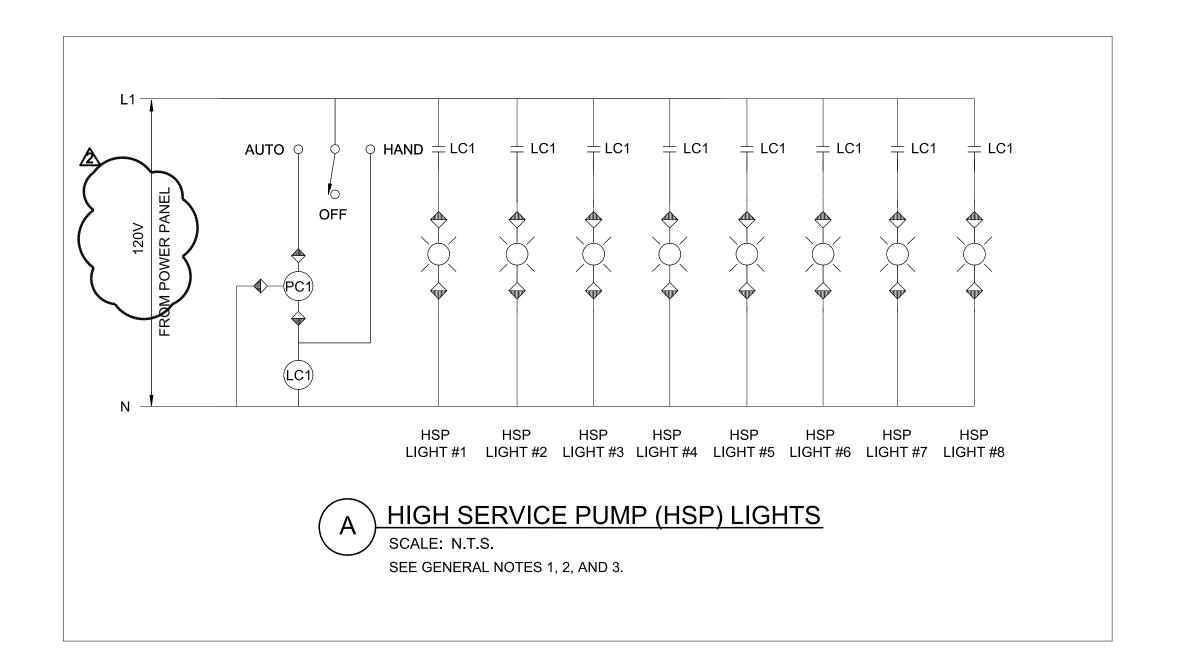
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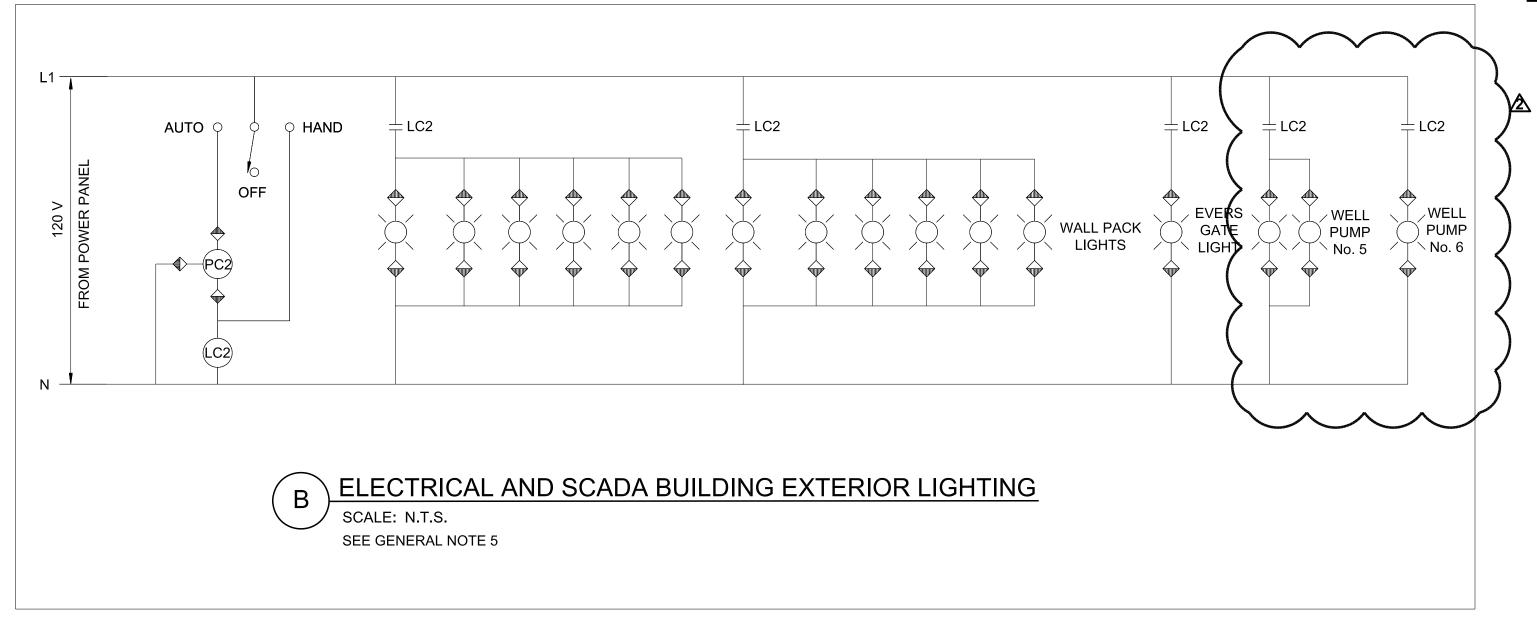
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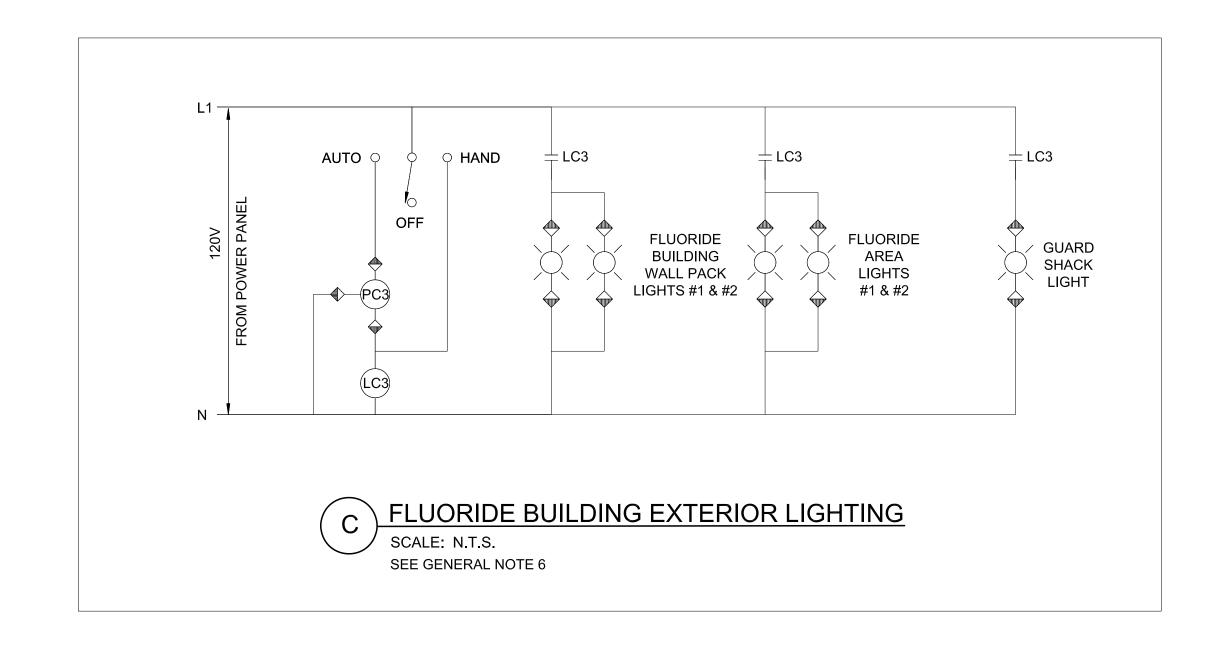
San Antonic Water System


SAN ANTONIO WATER SYSTEM
WURZBACH PUMP STATION IMPROVEMENTS
BUILDING FOUNDATION EXCAVATION

DRAWING NO.







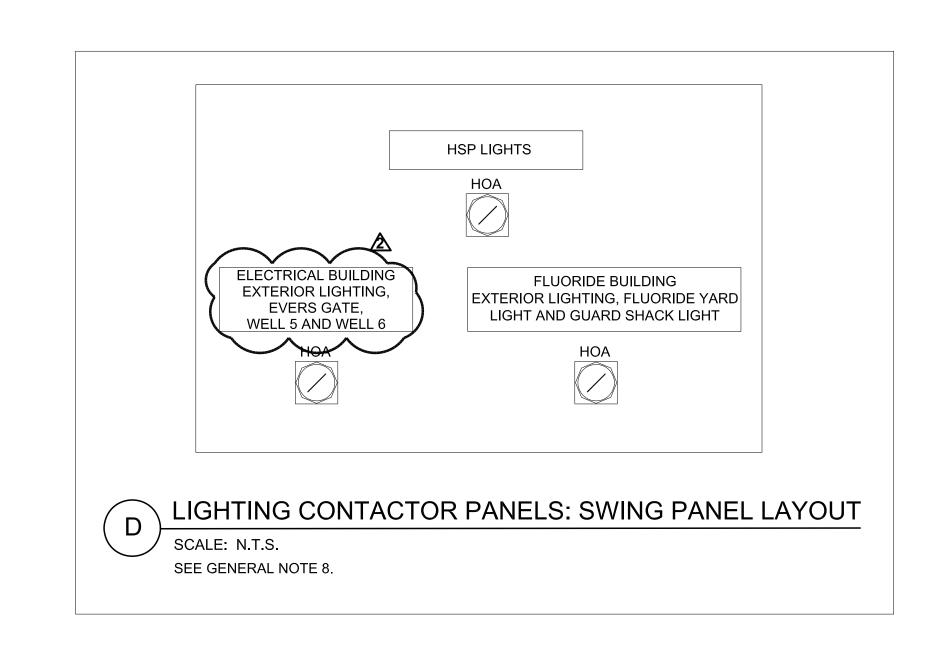


GENERAL NOTES:

- 1. INSTALL PHOTOCELL ON ELECTRICAL BUILDING SOUTH EXTERIOR WALL
- FOR HSP LIGHTS. 2. ALL ON/OFF SWITCHES SHALL BE TWO-POLE TYPE.
- 3. ALL SWITCHES NEED TO HAVE A MEANS OF LOCKOUT FOR SAFETY PURPOSES SHALL BE PROVIDED WITH MEANS FOR LOCKOUT DEVICE PER NFPA 70E.
- 4. REFER TO SPECIFICATION 16050 FOR SWITCH AND NAMEPLATE REQUIREMENTS.
- 5. INSTALL PHOTOCELL FOR DOORWAY LIGHTS ON ELECTRICAL BUILDING
- SOUTH EXTERIOR WALL. 6. INSTALL PHOTOCELL FOR DOORWAY LIGHTS ON ELECTRICAL BUILDING
- SOUTH EXTERIOR WALL.
- 7. INSTALL PHOTOCELL INTEGRATED TO EACH LIGHT.
- 8. INSTALL TAG LABELED "LIGHTING CONTACTOR PANEL" ON FRONT EXTERIOR OF PANEL.

JOB NO.

15-6003



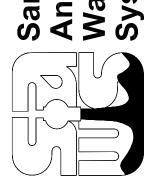

CONTROL **EXTERIOR LIGHTING**

DRAWING NO. **E30**

OF

TYPE: 250A COPPER BUS 100A MAIN BREAKER 208 / 120V 3-PHASE, 4-WIRE	POWER PANEL 'E' ELECTRICAL BUILDING								SERVICE ENTRANCE RATED WITH ISOLATED NEUTRAL BUS WITH ISOLATED GROUND BUS
LABEL	LOAD	BKR	POLE	CKT#	CKT#	POLE	BKR	LOAD	LABEL
ELECTRICAL BUILDING SWITCHGEAR/ MCC ROOM RECEPTACLES #1	0.7 kW	20	1	1	2	1	20	0.7 kW	ELECTRICAL BUILDING SWITCHGEAR/MCC ROOM RECEPTACLES #2
ELECTRICAL BUILDING SWITCHGEAR/ MCC ROOM EXIT LIGHTING #1	0.3 kW	20	1	3	4	1	20	0.5 kW	ELECTRICAL BUILDING SWITCHGEAR/MCC ROOM EXIT LIGHTING #2
ELECTRICAL BUILDING SWITCHGEAR/MCC ROOM LIGHTING	0.7 kW	20	1	5	6	1	20	0.5 kW	ELECTRICAL BUILDING SWITCHGEAR/MCC ROOM EMERGENCY LIGHTS
ELECTRICAL BUILDING BASEMENT EMERGENCY LIGHTING	0.3 kW	20	1	7	8	1	20	0.7 kW	ELECTRICAL BUILDING BASEMENT RECEPTACLES
ELECTRICAL BUILDING BASEMENT SUMP PUMP SP-1	1.92 W	20	1	9	10	1	20	0.5 kW	ELECTRICAL BUILDING BASEMENT ROOM LIGHTING
ELECTRICAL BUILDING BASEMENT EXIT LIGHTING	0.1 kW	20	1	11	12	1	20	0.5 kW	ELECTRICAL BUILDING ROOF RECEPTACLE
SPARE	-	20	1	13 15	14	1	20	0.5 kW	ELECTRICAL BUILDING EXTERIOR LIGHTING
SPARE	-	20	1	17	18	1	20	_	SPARE
SPARE	-	20	1	19	20	1	20	-	SPARE
SPARE	-	20	1	21	22	1	20	-	SPARE
SCADA/SECURITY ROOM RECEPTACLES	0.5 kW	20	1	23	24	1	20	0.7 kW	SCADA/SECURITY ROOM LIGHTING
SCADA/SECURITY ROOM EXIT LIGHTING	0.7 kW	20	1	25	26	1	20	-	SPARE
SPARE	-	20	1	27	28	1	20	-	SPARE
SPARE	-	20	1	29	30	1	20	-	SPARE
SPARE	-	20	1	31	32	1	20	-	SPARE
SPARE	-	20	1	33	34	1	20	-	SPARE
SPARE	-	20	1	35	36	1	20	-	SPARE
SPARE	-	20	1	37	38	2	40		POWER PANEL 'H' (SCADA ROOM)
SPARE	-	20	1	39	40	_			
SPARE	-	20	1	41	42			-	SPARE
	6.52 kW	6.52 kW TOTAL: 12.62 kW							

\bigcap	POWER PANEL 'E' LAYOUT
(^ /	SCALE: N.T.S.

TYPE: 250A COPPER BUS 100A MAIN BREAKER		F	POW	ER I	SERVICE ENTRANCE RATED				
208 / 120V 3-PHASE, 4-WIRE	ELECTRICAL BUILDING							WITH ISOLATED NEUTRAL BUS WITH ISOLATED GROUND BUS	
LABEL	LOAD	BKR	POLE	CKT#	CKT#	POLE	BKR	LOAD	LABEL
TANK 1 ROOF/RACK RECEPTACLES	0.5 kW	20	1	1	2	1	20	0.5 kW	TANK 2 ROOF/RACK RECEPTACLES
TANK 1 CONTROL RACK LIGHT	0.2 kW	20	1	3	4	1	20	0.2 kW	TANK 2 CONTROL RACK LIGHT
ANALYZER #1 RACK LIGHT	0.2 kW	20	1	5	6	1	20	0.2 kW	ANALYZER #2 RACK LIGHT
ANALYZER#1 POWER/HEATER	0.5 kW	20	1	7	8	1	20	0.5kW	ANALYZER#2 POWER/HEATER
GROUND STORAGE TANK No. 2 HEAT TRACE PANEL	0.3 kW	20	1	9	10	1	20	1.44 kW	LIGHTING CONTACTOR PANEL CKT. No. 2
LIGHTING CONTACTOR PANEL CKT. No. 1	0.55 kW	20	1	11	12	1	20	0.48 kW	LIGHTING CONTACTOR PANEL CKT. No. 3
SPARE	-	20	1	13	س4ر	1	20	0.5 kW	GROUND STORAGE TANK NO. 1 HEAT TRACE PANEL
GROUND STORGE TANK No. 2 LEVEL CONTROL PANEL	0.5 kW	20	1	15	16	1	20	0.5 kW	GROUND STORAGE TANK NO. 1 LEVEL CONTROL PANEL
SPARE	-	30	1	17	18	1	20	-	SPARE
SPARE	-	20	2	19	20	2	20	-	SPARE
				21	22				
TANK NO. 1 CATHODIC RECTIFIER PANEL	0.96kW	20	1	23	24	1	20	-	SPARE
SPARE	-	20	1	25	26	1	20	0.5 kW	TANK 2 LADDER LIGHT
SPARE	-	20	1	27	28	1	20	-	SPARE
SPARE	-	20	1	29	30	1	20	-	SPARE
SPARE	-	20	1	31	32	1	20	-	SPARE
				33	34	1	20		SPARE
SPARE	-	50	3	35	36				
				37	38	3	20	-	SPARE
SPARE	_	20	2	39	40				
				41	42	1	20		SPARE
	3.71 kW	KW TOTAL: 8.53 kW						4.82 kW	

POWER PANEL 'F' LAYOUT

SCALE: N.T.S.

GENERAL NOTES:

- 1. EACH CIRCUIT SHALL HAVE SEPARATE HOT, NEUTRAL, GROUND WIRES.
- 2. DO NOT SHARE NEUTRAL OR GROUND WIRES FROM OTHER CIRCUITS.

ЈОВ NO. 15-6003

Drn. Approved Date
11-6-18
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 ENGINEERING, INC.
 ADDENDUM No. 4
 App

 ICAL POWER SYSTEMS
 SIGN AND TESTING
 ADDENDUM No. 4

 REGISTRATION NO. 3904
 SYSS, SAN ANYONO, TEXAS 78212
 ADDENDUM No. 4

 REGISTRATION NO. 3904
 AVIOLOGE SS 9805
 ADDENDUM No. 4

Date: AUGUST 2018
Drawn by: SG
Designed by: SM, JDP, C
Checked by: SM

San Antonio Water System

SAN ANTONIO WATER SYSTEM
WURZBACH PUMP STATION IMPROVEMENTS
POWER PANEL SCHEDULE - III

DRAWING NO.

E33

OF